**5TH & BROAD** 

110 SE 8th Ave Portland, OR 97214


BOISE, ID 83702

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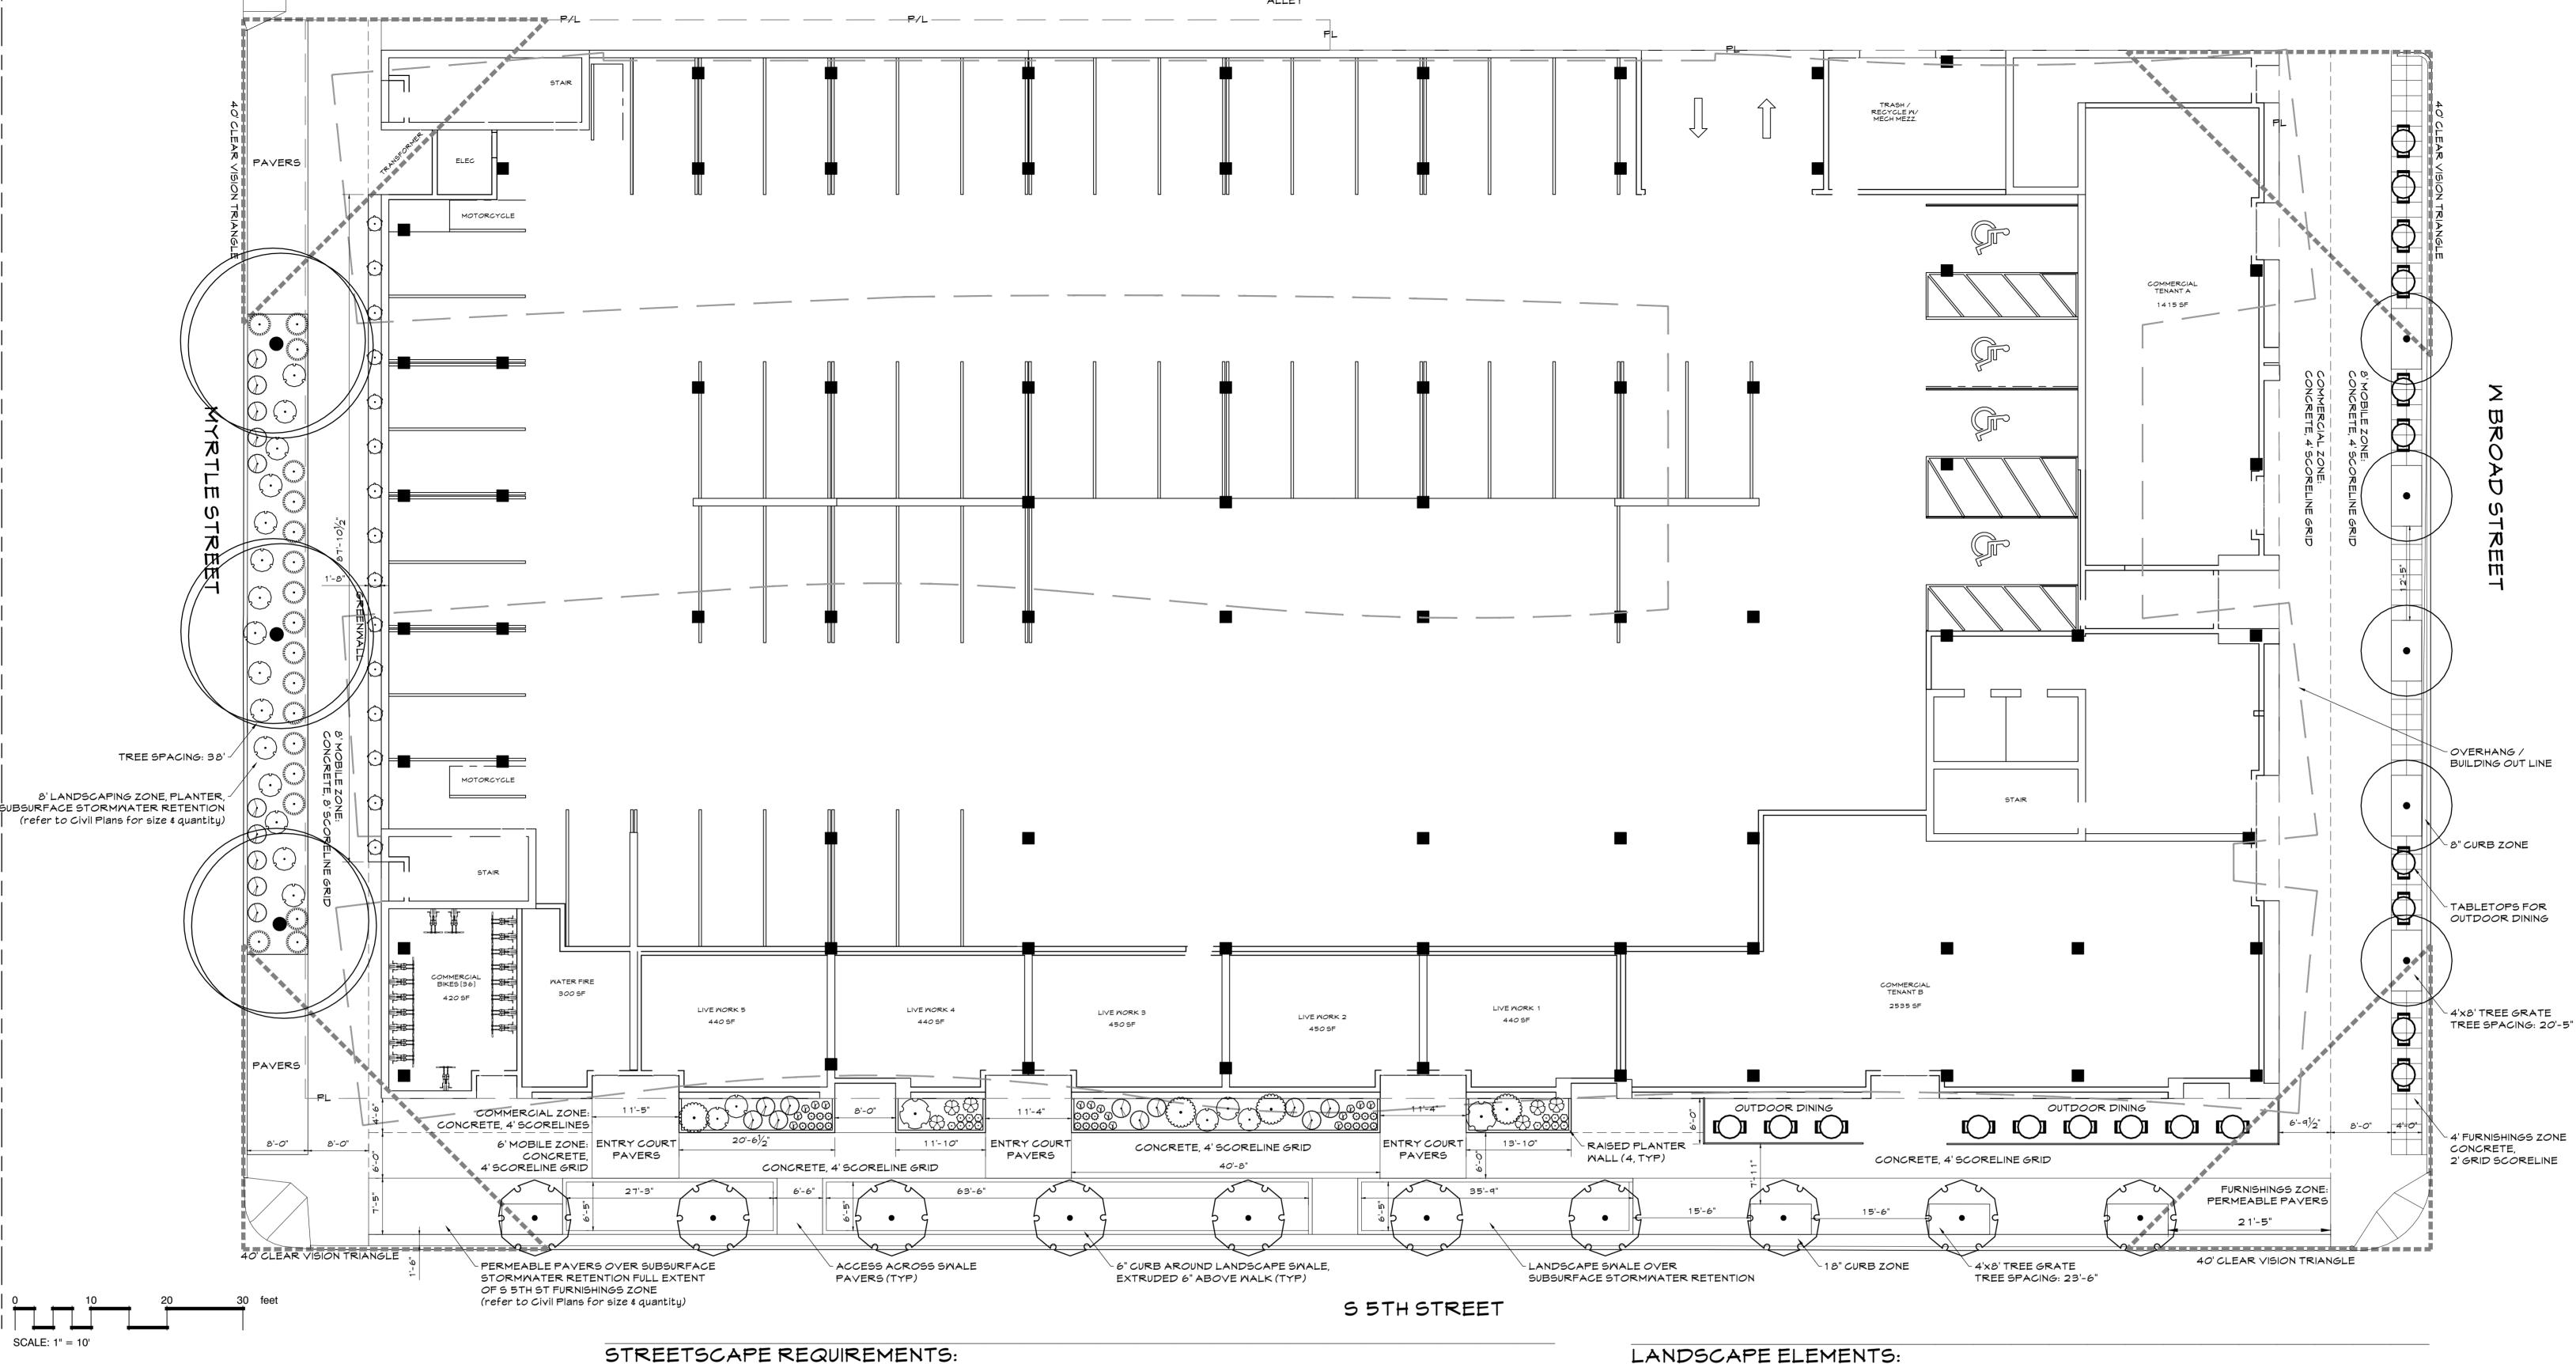
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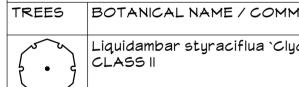


SCHEMATIC DESIGN

DESIGN REVIEW

revision list

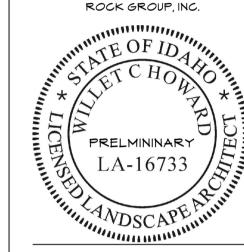



PLANT SCHEDULE

CONT CAL TREES BOTANICAL NAME / COMMON NAME QTY B & B 2"Cal |Liquidambar styraciflua `Clydesform` / Emerald Sentinel Sweet Gum Pyrus calleryana `Chanticleer` / Chanticleer Pear B & B 2"Cal CLASSI B & B 2"Cal Tilia cordata 'Greenspire' / Greenspire Littleleaf Linden CLASS II SHRUBS | BOTANICAL NAME / COMMON NAME SIZE FIELD2 Calamagrostis x acutiflora 'Karl Foerster' / Feather Reed Grass Caryopteris x clandonensis `Blue Mist` / Blue Mist Shrub 2 gal 5 gal Euonymus fortunei 'Moonshadow' TM / Moonshadow Euonymus 14 1 gal |Festuca glauca `Elijah Blue` / Blue Fescue Hosta x `Big Daddy` / Plantain Lily 1 gal Lavandula angustifolia `Hidcote Blue` / Hidcote Blue Lavender 2 gal Ophiopogon planiscapus 'Nigrescens' / Black Mondo Grass 1 gal 21 15 |Parthenocissus tricuspidata / Virginia Creeper 1 gal Pennisetum alopecuroides `Hameln` / Hameln Dwarf Fountain Grass Pennisetum alopecuroides `Little Bunny` / Little Bunny Fountain Grass | 1 gal

MYRTLE STREET: CCDC TYPE 5 STREETSCAPE: URBAN PARKWAY

1 TREE PER 50LF; 162LF - 3 TREES REQUIRED, 3 TREES PROVIDED 8' MIN LANDSCAPE ZONE, 8' MIN MOBILE ZONE, CONCRETE W/ 8' MIN SCORELINES

• S 5TH STREET: CCDC TYPE 4 STREETSCAPE: NEIGHBORHOOD

1 TREE PER 30LF; 288LF - 10 TREES REQUIRED, 10 TREES PROVIDED 18" CURB ZONE, 6' MIN FURNISHINGS ZONE, 6' MIN MOBILE ZONE, CONCRETE 4' MIN SCORELINES

9.1. Follow local city codes when connecting to city water.

9.3. Do not exceed water velocities of over 5ft. per second.

over 4" depth of  $\frac{3}{4}$ " road mix compacted to 95% proctor.

11. Trees or shrubs over 18" to be planted in 40 clear vision

14. All plant material shall be installed per industry standards.

for Nursery Stock. Plants not meeting these standards for

quality, or plants determined to be unhealthy by Owner's

period 30 days beginning at the date of Acceptance by

immediately with same type and size at no cost to the Owner.

18. Contractor is responsible for maintaining drainage away from

Owner. Replace all dead or unhealthy plant material

15. All plant material shall meet or exceed minimum federal

representative will be rejected.

all structures per local codes.

immediately.

per manufacturers recommendations.

adequate water to each plant species.

1 STREET LIGHT PER 60 LF, 5 LIGHTS M BROAD STREET: CCDC TYPE 3 STREETSCAPE: URBAN CONCRETE

1 TREE PER 30LF; 158LF - 5 TREES REQUIRED, 5 TREES PROVIDED

8" CURB ZONE, 4' FURNISHINGS ZONE W/ CONCRETE 2' MIN SCORELINES ,

8' MIN MOBILE ZONE W/ CONCRETE 4' MIN SCORELINES 1 STREET LIGHT PER 60 LF, 3 LIGHTS

1 STREET LIGHT PER 60LF, 3 LIGHTS

## LANDSCAPE NOTES:

All contractor work shall be conducted in accordance with ISPMC (Idaho Standard Public Morks Construction), 2015; 9.2. All planters to receive drip irrigation that provides and City of Boise, ID codes, standards and state and local regulations.

10. Provide 18" min soil plating medium for shrubs in planters, 2. All utilities shall be located prior to construction and protected. Any damage to structures, utilities or concrete will be replaced at contractors expense.

3. The site has many existing improvements such as underground triangles located at intersections & alley access. utilities, fencing, curb and gutter, etc. It is the contractors 12. All Ball and Burlap trees to be installed per detail 1/L1.01. responsibility to protect and retain the existing site to the 13. All shrubs to be installed per detail 2/L1.01. best of their ability. All damages to existing site shall be repaired to the homeowner's satisfaction.

If during the construction process it is determined that there standards as regulated by ANSI z60.1 American Standard is not suitable topsoil on site to support a new lawn notify project owner immediately.

5. Pavers located on site to be Ironspot Manganese in herringbone pattern, 2-1/4"x8" by Endicott Clay Products 16. Fertilize all trees and shrubs with 'Agriform' planting tablets as recommended by CCDC & City of Boise. 6. Tree grates to be 4'x8' rectangular cast iron 'KIVA' model 17. All landscaping work and material to be guaranteed for a

grate and fram by Urban Accessories Site storm water to be contained within landscape-site furnishings zone in subsurface medium along Myrtle St & S 5th

7.1. Refer to Civil Plans for sizing & quantity.

8. Estimated quantities are shown for general reference only. 19. In the event of a discrepancy, notify the Landscape Architect Contractor shall be responsible for all quantity estimates.

9. Irrigation system to be design build by contractor.

• PAVERS: IRONSPOT MANGANESE, HERRINGBONE PATTERN • TREE GRATES: 4'x8' rectangular cast iron 'KIVA' model

(see notes)

## DO NOT DAMAGE OR CUT LEADER

2. DO NOT DISTURB ROOT OR DAMAGE ROOT BALL WHEN INSTALLING TREE OR TREE . TREE STAKING SHALL BE AT THE DISCRETION OF CONTRACTOR, HOWEVER ANY

TREES DISTURBED FROM PLUMB DURING THE PLANT WARRANTEE PERIOD WILL BE REPAIRED OR REPLACED AT CONTRACTOR'S EXPENSE.

 WATER PLANTS THOROUGHLY IMMEDIATELY AFTER INSTILLATION. 5. REMOVE ALL BURLAP, TWINE, ROPE, OR MATERIAL FROM THE TOP  $\frac{1}{3}$  OF THE

MULCH MIN. DO NOT PLACE MULCH WITHIN 2" OF TRUNK OF TREE.

6. 5' DIAMETER PLANTER BED/MULCH RING AROUND THE TRUNK OF THE TREE. 3" OF

STRUCTURAL GRAFT VISIBLE ABOVE ROOTS: <3" BELOW TOP OF ROOTBALL. SOIL LINE OF THE TOP OF THE ROOT BALL AFTER STRUCTURAL ROOT REMOVING EXCESS SOIL. <5" BELOW TOP OF 2-3" OF MULCH ROOT BALL BACKFILL MIX SEE NOTES AND SPECIFICATIONS. REMOVE AT END OF PROJECT CUT AND FOLD WIRE BASKET FROM TOP OF COMPACT SOIL UNDER ROOTBALL ROOTBALL TO 90%

BALL AND BURLAP TREE PLANTING 329343.33-05 3/4" = 1'-0"

PLANT OR ROOT MASS. HEIGHT ABOVE EXISTING SOILS WHEN COMPLETE. MULCH 2" MIN. AWAY FROM TRUNK OF PLANT FOLD BURLAP FROM 3" DEEP MULCH TOP OF ROOT BALL DOWN INTO GROUND; SET TOP OF BALL FLUSH MITH FINISH LAWN OR PAVING GRADE 12" TO 18" FOR LARGER SHRUB ROOT BALLS, MAKE DEPTH MIN. 4" DEEPER THAN BALL) BALL AND BURLAP PLANT (IF CONTAINER - GROWN PLANT WITH ROOTS SOIL SURFACE-LOOSENED AND PULLED ROUGHENED TO OUT TO PREVENT PLANT BIND MITH NEW FROM BECOMING ROOT

BACKFILL SHALL BE 100%

ROOTBALL MAINTAINS 1

TOPSOIL. WATER SETTLE ALL PLANTINGS TO ENSURE PLANT

PROCTOR.

REMOVE ALL TAGS, TWINE OR OTHER NON BIODEGRADABLE

MATERIALS ATTACHED TO

BOUND) SHRUB PLANTING 329333.16-01 LANDSCAPE PLAN

04.07.2015

sheet title:

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LANDSCAPE SITE PLAN