2. All structures, site improvements and underground utilities shall be located prior to construction and protected. Call Digline (811) to locate underground utilities. Any damage to structures, utilities or concrete will be replace at contractor's expense.

3. Coordinate with civil engineering drawings for paving, utilities and grading information.

4. Prepare site for planting by grubbing and removing weeds. If necessary apply Round-up (or equivalent herbicide), using a certified Applicator. Remove rocks and other materials over 3".

All lawn areas shall have min 6" of topsoil and and fill tree pits with topsoil. Topsoil shall be friable loam, pH range 5.5 to 7, a minimum of 5% organic material, free of stones 1 inch or larger or any other extraneous materials. It is acceptable to amend native soils to meet this topsoil specification if soil texture is loamy.

6. If work is in the Spring, between the months March to May, then apply pre-emergant to all non-paved landscape areas, except areas receiving grass sod, prior to planting.

7. Berming and grading as shown on plans shall have gradual transitions to existing or engineer proposed grades. Grading shall not change flow or direction of surface drainage swales as shown on engineers plans positive drainage away from structures. Refer to Engineer's plans for grading information.

6. Surface water drainage is to be contained within each lot unless expressly allowed otherwise by approved engineering plans.

7. Estimated quantities are shown for general reference only. Contractor shall be responsible for all quantity estimates.

8. Lay sod within 24 hours of harvesting. Lay sod to form a solid mass with tightly fitted joints and even

9. Contractor responsible for keeping landscaped areas clean. remove all debris, spoils and trash from site for disposal at approved landfill or waste disposal site.

10. All plant material shall meet or exceed the minimum federal standards as regulated by ANSI z60.1, American Standard for Nursery Stock. Plants not meeting these standards for quality, or plants determined to be unhealthy by Owner's representative, will be rejected.

11. Install only specified plants. Plant substitutes must be approved by Landscape Architect. Unapproved plant substitutes will be replaced at Contractor's expense.

12. Trees shall not be planted within the 10' clear zone of all ACHD (Ada County Highway District) storm drain pipe, structures, or facilities.

13. Trees shall not be planted within clear vision

14. No trees shall be placed within 50' of stop sign.

15. Seepage beds must be protected from any and all contamination during the construction and installation of the landscape irrigation system.

16. Root barriers must be used for trees in street planters with a minimum width of six (6) feet. Root barriers are required to extend 18 inches below the sub grade on the sidewalk side and shall extend 2 feet below sub grade on curb side. Barrier shall be constructed with the street and sidewalk and shall run continuously along sidewalk and curb.

17. All plant material shall be guaranteed for a period of 30 days beginning a the date of Acceptance by Owner. Replace all dead or unhealthy plant material immediately with same type and size at no cost to the Owner.

18. All landscape shall be irrigated with an automatic irrigation system operated by one controller, and designed with hydro-zones that function well within the water service provided for healthy growth of plant material. Year-round pressure irrigation service is required.

19. The irrigation system shall be designed and installed with the following specifications:

Coverage for different hydrozones:

a. Lawns - Pop-up rotor sprinklers or MP rotor sprinklers with 100% double coverage.

b. Planting Beds - Pop-up sprinklers.

Sprinkler heads shall have matched precipitation rates within each control valve circuit.


 Separate hydrozones shall be used for lawns and trees/shrubs/ground cover areas.


 Sprinklers shall not overspray onto impervious surfaces, building or structures in calm wind conditions.

22. Contractor shall submit shop drawings of design/build irrigation system and/or any materials or product substitutes to Owner's Representative for approval prior to construction. Shop drawings shall include at minimum: design layout, backflow system, controller and value locations, sleeve locations and supply line size and location.

23. Irrigation Contractor to coordinate with General Contractor for all sleeves that need to be installed to allow efficient irrigation piping.

24. Irrigation controllers shall be pedestal mounted in planting beds. Controller locations shall be easily accessible, but visibly discrete.

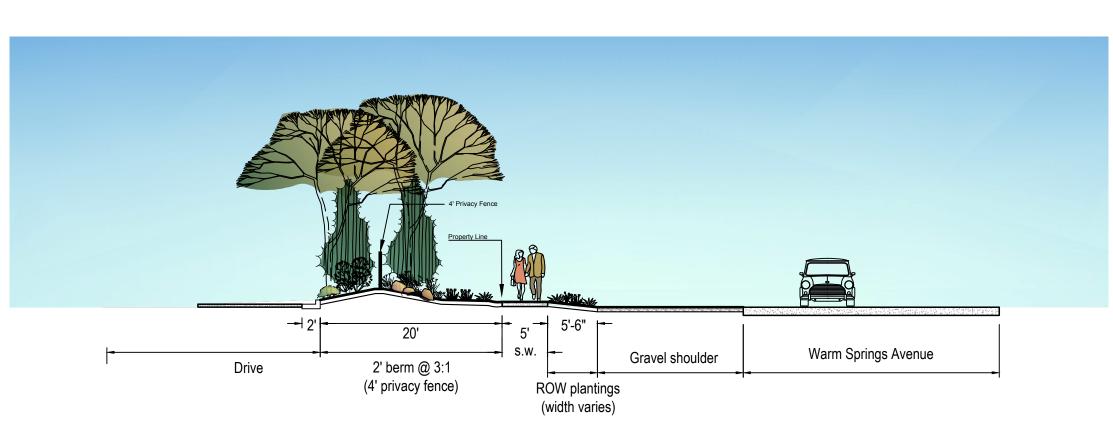

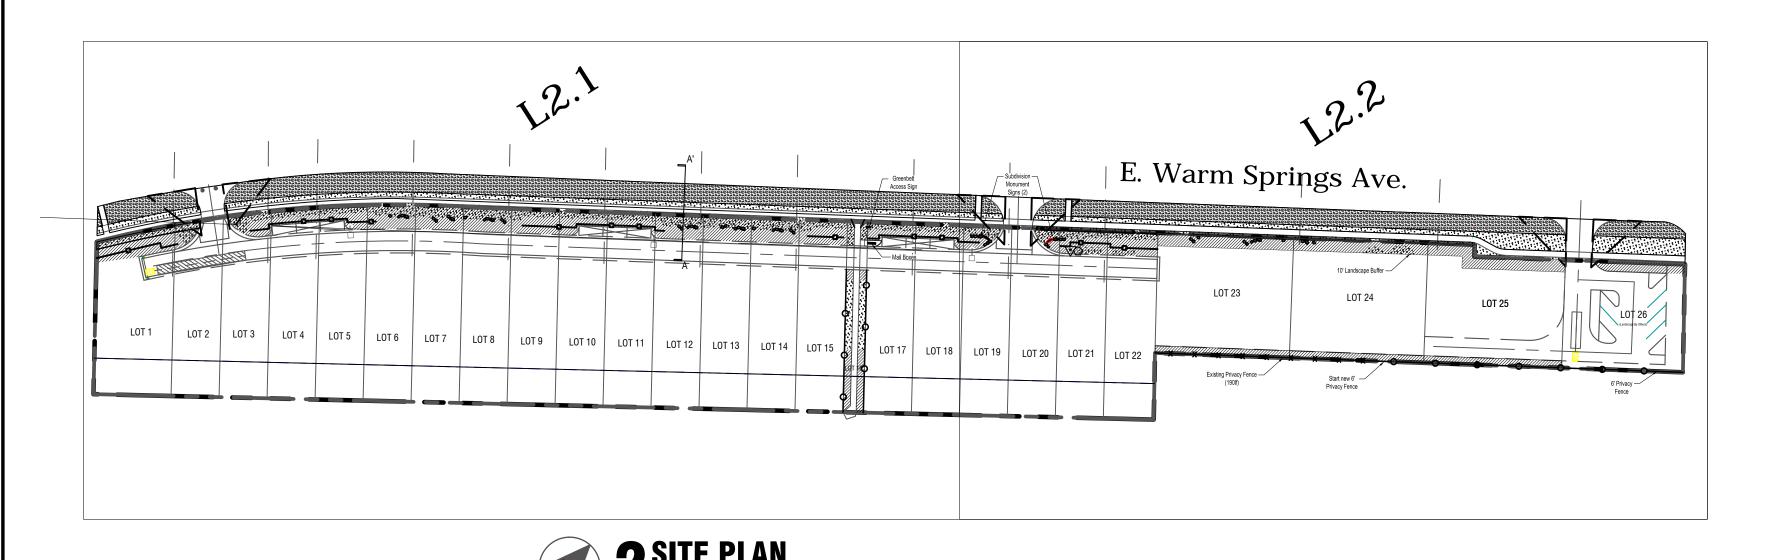

SCALE: 1" = 150'-0"

MASTER PLANTING SCHEDULE Mature Size Water zone Class **Botanical Name** Planting Common Name Quant. L2.1 Quant. L2.2 (HxW) (0-4)Height Size* Acer truncatum x platanoides PACIFIC SUNSET MAPLE or 60'x40' 3-4 'Warrenred' or Acer fremanii 2" cal. AUTUMN BLAZE MAPLE 'Jeffersred' Gleditsia triacanthos inermis SKYLINE HONEYLOCUST 45'x35' AMUR MAPLE 2" cal. Acer ginnala 20'x25' Amelanchier x grandiflora ROBINHILL SERVICEBERRY or 9'-10' ht 3-4 'Robinhill' or Prunus virginiana 25'x15' (clump) CANADA RED CHOKECHERRY 'Canada Red' Pinus flexilis 'Vanderwolf's EVERGREEN **VANDERWOLF PINE** 30'x15' 6'-7' ht. Pyramid' KARL FUCHS HIMALAYAN CEDAR Cedrus deodara 'Karl Fuchs' 20'x8' EVERGREEN DARTS GOLD NINEBARK or Physocarpus opulifolius 'Darts 5 gal SHRUB 6'x6' SASKATOON SERVICEBERRY Gold' or Amelanchier alnifolia 5 gal SHRUB 10 SCHIPKA CHERRY LAUREL Prunus laurocerasus 14 £:3 BAILEYS REDOSIER DOGWOOD Cornus sericea 'Baileys' 7'x7' 5 gal 12 27 SHRUB 52 RUSSIAN SAGE 5'x5' 2-3 gal. SHRUB Perovskia atriplicifolia Pinus mugo 'Slowmound' 2-3 gal. E. SHRUB 12 SLOWMOUND DWARF MUGO PINE 2'x3' 2-3 gal. SHRUB 25 30 GROW LOW SUMAC 3'x6' Rhus aromatica Parthenocissus quinquefolia 12'x5' 2-3 gal. VINE VIRGINIA CREEPER KARL FOERSTER FEATHER REED Calamagrostis acutiflora 'Karl 5'x2' 1 gal GRASS Foerster' Perennial Beds Mix. Final location and Lavandula angustifolia 'Hidcote HIDCOTE SUPERIOR LAVENDER 1 gal quantity to be determined in construction 2'x2' PERENNIAL plans. See Note 3. Perennial Beds Mix. Final location and 1 gal quantity to be determined in construction FIRECRACKER PENSTEMON Penstemon eatonii 3'x2' PERENNIAL plans. See Note 3. Perennial Beds Mix. Final location and quantity to be determined in construction **BLACK EYED SUSAN** 1.5'x1' PERENNIAL Rudbeckia hirta plans. See Note 3. Perennial Beds Mix. Final location and BLUE FLAX 1.5'x1.5' PERENNIAL quantity to be determined in construction Linium lewisii plans. See Note 3. Perennial Beds Mix. Final location and HARDY ICE PLANT quantity to be determined in construction Delosperma cooperii 2"x18" PERENNIAL plans. See Note 3. Perennial Beds Mix. Final location and Pennisetum alopecuroides 'Little LITTLE BUNNY FOUNTAIN GRASS quantity to be determined in construction 3'x2' 1 gal GRASS

1. SEE GENERAL NOTES (THIS PAGE). ALSO SEE PAGE L3 FOR PLANTING DETAILS

2. WATER ZONES SHOWN IN THE MINIMUM NUMBER OF IRRIGATION APPLICATIONS PER MONTH REQUIRED FOR HEALTHY GROWTH (SEE BOISE PARKS AND RECS WATER CONSERVATION GUIDELINES and SALT LAKE CITY

3. FINAL LOCATION AND QUANTITY OF PERENNIALS TO BE DETERMINED IN CONSTRUCTION PLANS. TOTAL PLANT COVERAGE IN PLANTER BEDS TO BE MINIMUM 60% WITHIN 3 YEARS.

Key	LANDSC Material	Description	Notes/Remarks
	Gravel Shoulder	Road Mix	ACHD Right-of-Way
	Planter Beds	Medium Shredded Bark Mulch and plants per planting plan	2.5 " to 3" deep medium shredded bark mulch throughout. All plants drip irrigated.
	Clear Vision Triangle	Triangle formed 40' along curb lines	See plans
	Micro Path - 5'	5' asphalt path with min. 5' landscape buffers each side	Per plans. See Engineer's plans for paving details and specifications.
	Privacy Fence - 6'	Wood 6', Stained brown color	Per detail L3.2 Perimeter fencing as shown on plans
	Privacy Fence - 4'	Wood 4', Stained brown color	Per detail L3.2 Perimeter fencing as shown on plans
•	Irrigation Main and Drain	City Water Source	Main valve and drain with Double-Check Backflow Prevention Value, per codes
©	Irrigation Controller	Hunter I-Core	See L3.7 Pedestal Mount , lockable metal exterior box. Locate at convenient, but discrete serviceable locations.
400	Boulders	1/2 to 2 ton basalt	Bury into slope and toe at least 4"-6"
_ ₊₁ _	Contours	1 ft Contour interval. Berms and swales	Slopes not to exceed 3:1. Gentle transitions to Engineer's proposed grading.

TABLE OF CONTENTS						
SHEET NO.	SHEET NAME					
L1	LANDSCAPE COVER SHEET					
L2.1	LANDSCAPE PLANTING PLAN					
L2.2	LANDSCAPE PLANTING PLAN					
L3	LANDSCAPE DETAILS					

plans. See Note 3.

LANDSCAPE CALCULATIONS Street Buffers: Warm Springs Avenue 1,330 I.f., 20' min width (3' berm; intermittent 4' privacy fence; (32) evergreen trees; (27) canopy trees; (10)

DEVELOPER/APPLICANT DEVCO, LLC Contact: Jim Conger 4824 W Fairview Ave.

BOISE. ID 83702 (208) 336-8181 LANDSCAPE ARCHITECT

ornamental trees and shrubs. 60% coverage min.)

2471 TITANIUM PL., MERIDIAN, ID 83642 (208) 323-2288

ENGINEER ROCK SOLID CIVIL, LLC Contact: Randy Carpenter 270 n. 27th St., suite 100 Boise, ID 83702 (208) 342-3277

		REVISIONS		E-FILE NAME
מבוו	NO.		DATE	160030-LSCP
	-	New site plan with 30ft defensible zone and 20ft LS buffer	03/14/2016	DESIGNED
ANNERS	2	Change sidewlak locations	03/29/2016	S. PARKS
	3	Site plan changes - south side	08.23.2016	DRAWN
	4	City of Boise Revised Conditions	09.14.2016	S. PARKS
				СНЕСКЕР
323-2399				
HINGTON E, IDAHO				APPROVED

ENGE

LANDSCAPE **UBDIVISIO PRELIMINARY** BC

> MARCH 2016 160030

LOT 1

LOT 3

LOT 4

LOT 5

LOT 6

LOT 7

LOT 8

LOT 2

2,50 m Color	DARTS GOLD NINEBARK or SASKATOON SERVICEBERRY	Physocarpus opulifolius 'Darts Gold' or Amelanchier alnifolia	5 gal	4
*	SCHIPKA CHERRY LAUREL	Prunus laurocerasus	5 gal	0
	BAILEYS REDOSIER DOGWOOD	Cornus sericea 'Baileys'	5 gal	15
*	RUSSIAN SAGE	Perovskia atriplicifolia	2-3 gal.	28
•	DWARF MUGO PINE	Pinus mugo 'Slowmound'	2-3 gal.	19
\odot	GROW LOW SUMAC	Rhus aromatica	2-3 gal.	25
@	VIRGINIA CREEPER	Parthenocissus quinquefolia	2-3 gal.	40
Ð	KARL FOERSTER FEATHER REED GRASS	Calamagrostis acutiflora 'Karl Foerster'	1 gal	52

* * * * * * * * * * * * * * * * * * * *	HIDCOTE SUPERIOR LAVENDER	Lavandula angustifolia 'Hidcote Superior'	1 gal	Perennial Beds Mix. Final location and quantity to be determined in construction plans. See Note 3.
* * * * * * * * * * * * * * * * * * * *	FIRECRACKER PENSTEMON Penstemon eatonii		1 gal	Perennial Beds Mix. Final location and quantity to be determined in construction plans. See Note 3.
* * * * * * * * * * * * * * * * * * * *	BLACK EYED SUSAN	Rudbeckia hirta	1 gal	Perennial Beds Mix. Final location and quantity to be determined in construction plans. See Note 3.
* * * * * * * * * * * * * * * * * * *	BLUE FLAX Linium lewisii		1 gal	Perennial Beds Mix. Final location and quantity to be determined in construction plans. See Note 3.
	HARDY ICE PLANT	Delosperma cooperii	1 gal	Perennial Beds Mix. Final location and quantity to be determined in construction plans. See Note 3.
	LITTLE BUNNY FOUNTAIN GRASS	Pennisetum alopecuroides 'Little Bunny'	1 gal	Perennial Beds Mix. Final location and quantity to be determined in construction plans. See Note 3.

<u>NOTES</u> 1. SEE 0

4. PLANTS SHOWN AT NEAR MATURE SIZE.

1. SEE GENERAL NOTES (THIS PAGE). ALSO SEE PAGE L3 FOR PLANTING DETAILS
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3. FINAL LOCATION AND QUANTITY OF PERENNIALS TO BE DETERMINED IN CONSTRUCTION PLANS. TOTAL PLANT COVERAGE IN PLANTER BEDS TO BE 60% AT MATURITY.

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Greenbelt
Access Sign

Mail Boxes

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PLANTING PLAN

LOT 10

LOT 11

LOT 12


LOT 13

LOT 14

LOT 15

LOT 17

LOT 18

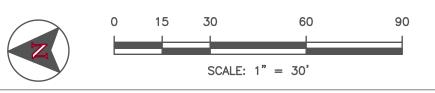

LOT 9

PRELIMINARY PLAT LANDSCAPE PLAN

BCI SUBDIVISION

	P	LANTING SCHEDULE		
Key	Common Name	Min. Planting Size*	Quant. L2.2	
* =	PACIFIC SUNSET MAPLE or AUTUMN BLAZE MAPLE	Acer truncatum x platanoides 'Warrenred' or Acer fremanii 'Jeffersred'	2" cal.	0
	SKYLINE HONEYLOCUST	Gleditsia triacanthos innermis 'Skyline'	2" cal.	8
	AMUR MAPLE	Acer ginnala	2" cal.	2
	ROBINHILL SERVICEBERRY or CANADA RED CHOKECHERRY	Amelanchier x grandiflora 'Robinhill' or Prunus virginiana 'Canada Red'	9'-10' ht (clump)	2
	VANDERWOLF PINE	Pinus flexilis 'Vanderwolf's Pyramid'	6'-7' ht.	6
AND	KARL FUCHS HIMALAYAN CEDAR	Cedrus deodara 'Karl Fuchs'	6'-7' ht.	10

AND CORP	DARTS GOLD NINEBARK or SASKATOON SERVICEBERRY	Physocarpus opulifolius 'Darts Gold' or Amelanchier alnifolia	5 gal	3
	SCHIPKA CHERRY LAUREL	Prunus laurocerasus	5 gal	10
	BAILEYS REDOSIER DOGWOOD	Cornus sericea 'Baileys'	5 gal	12
*	RUSSIAN SAGE	Perovskia atriplicifolia	2-3 gal.	24
•	DWARF MUGO PINE	Pinus mugo 'Slowmound'	2-3 gal.	12
\odot	GROW LOW SUMAC	Rhus aromatica	2-3 gal.	30
@	VIRGINIA CREEPER	Parthenocissus quinquefolia	2-3 gal.	7
Đ	KARL FOERSTER FEATHER REED GRASS	Calamagrostis acutiflora 'Karl Foerster'	1 gal	25

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* * * * * * * * * * * * * * * * * * *	LITTLE BUNNY FOUNTAIN GRASS	Pennisetum alopecuroides 'Little Bunny'	1 gal	Perennial Beds Mix. Final location and quantity to be determined in construction plans. See Note 3.

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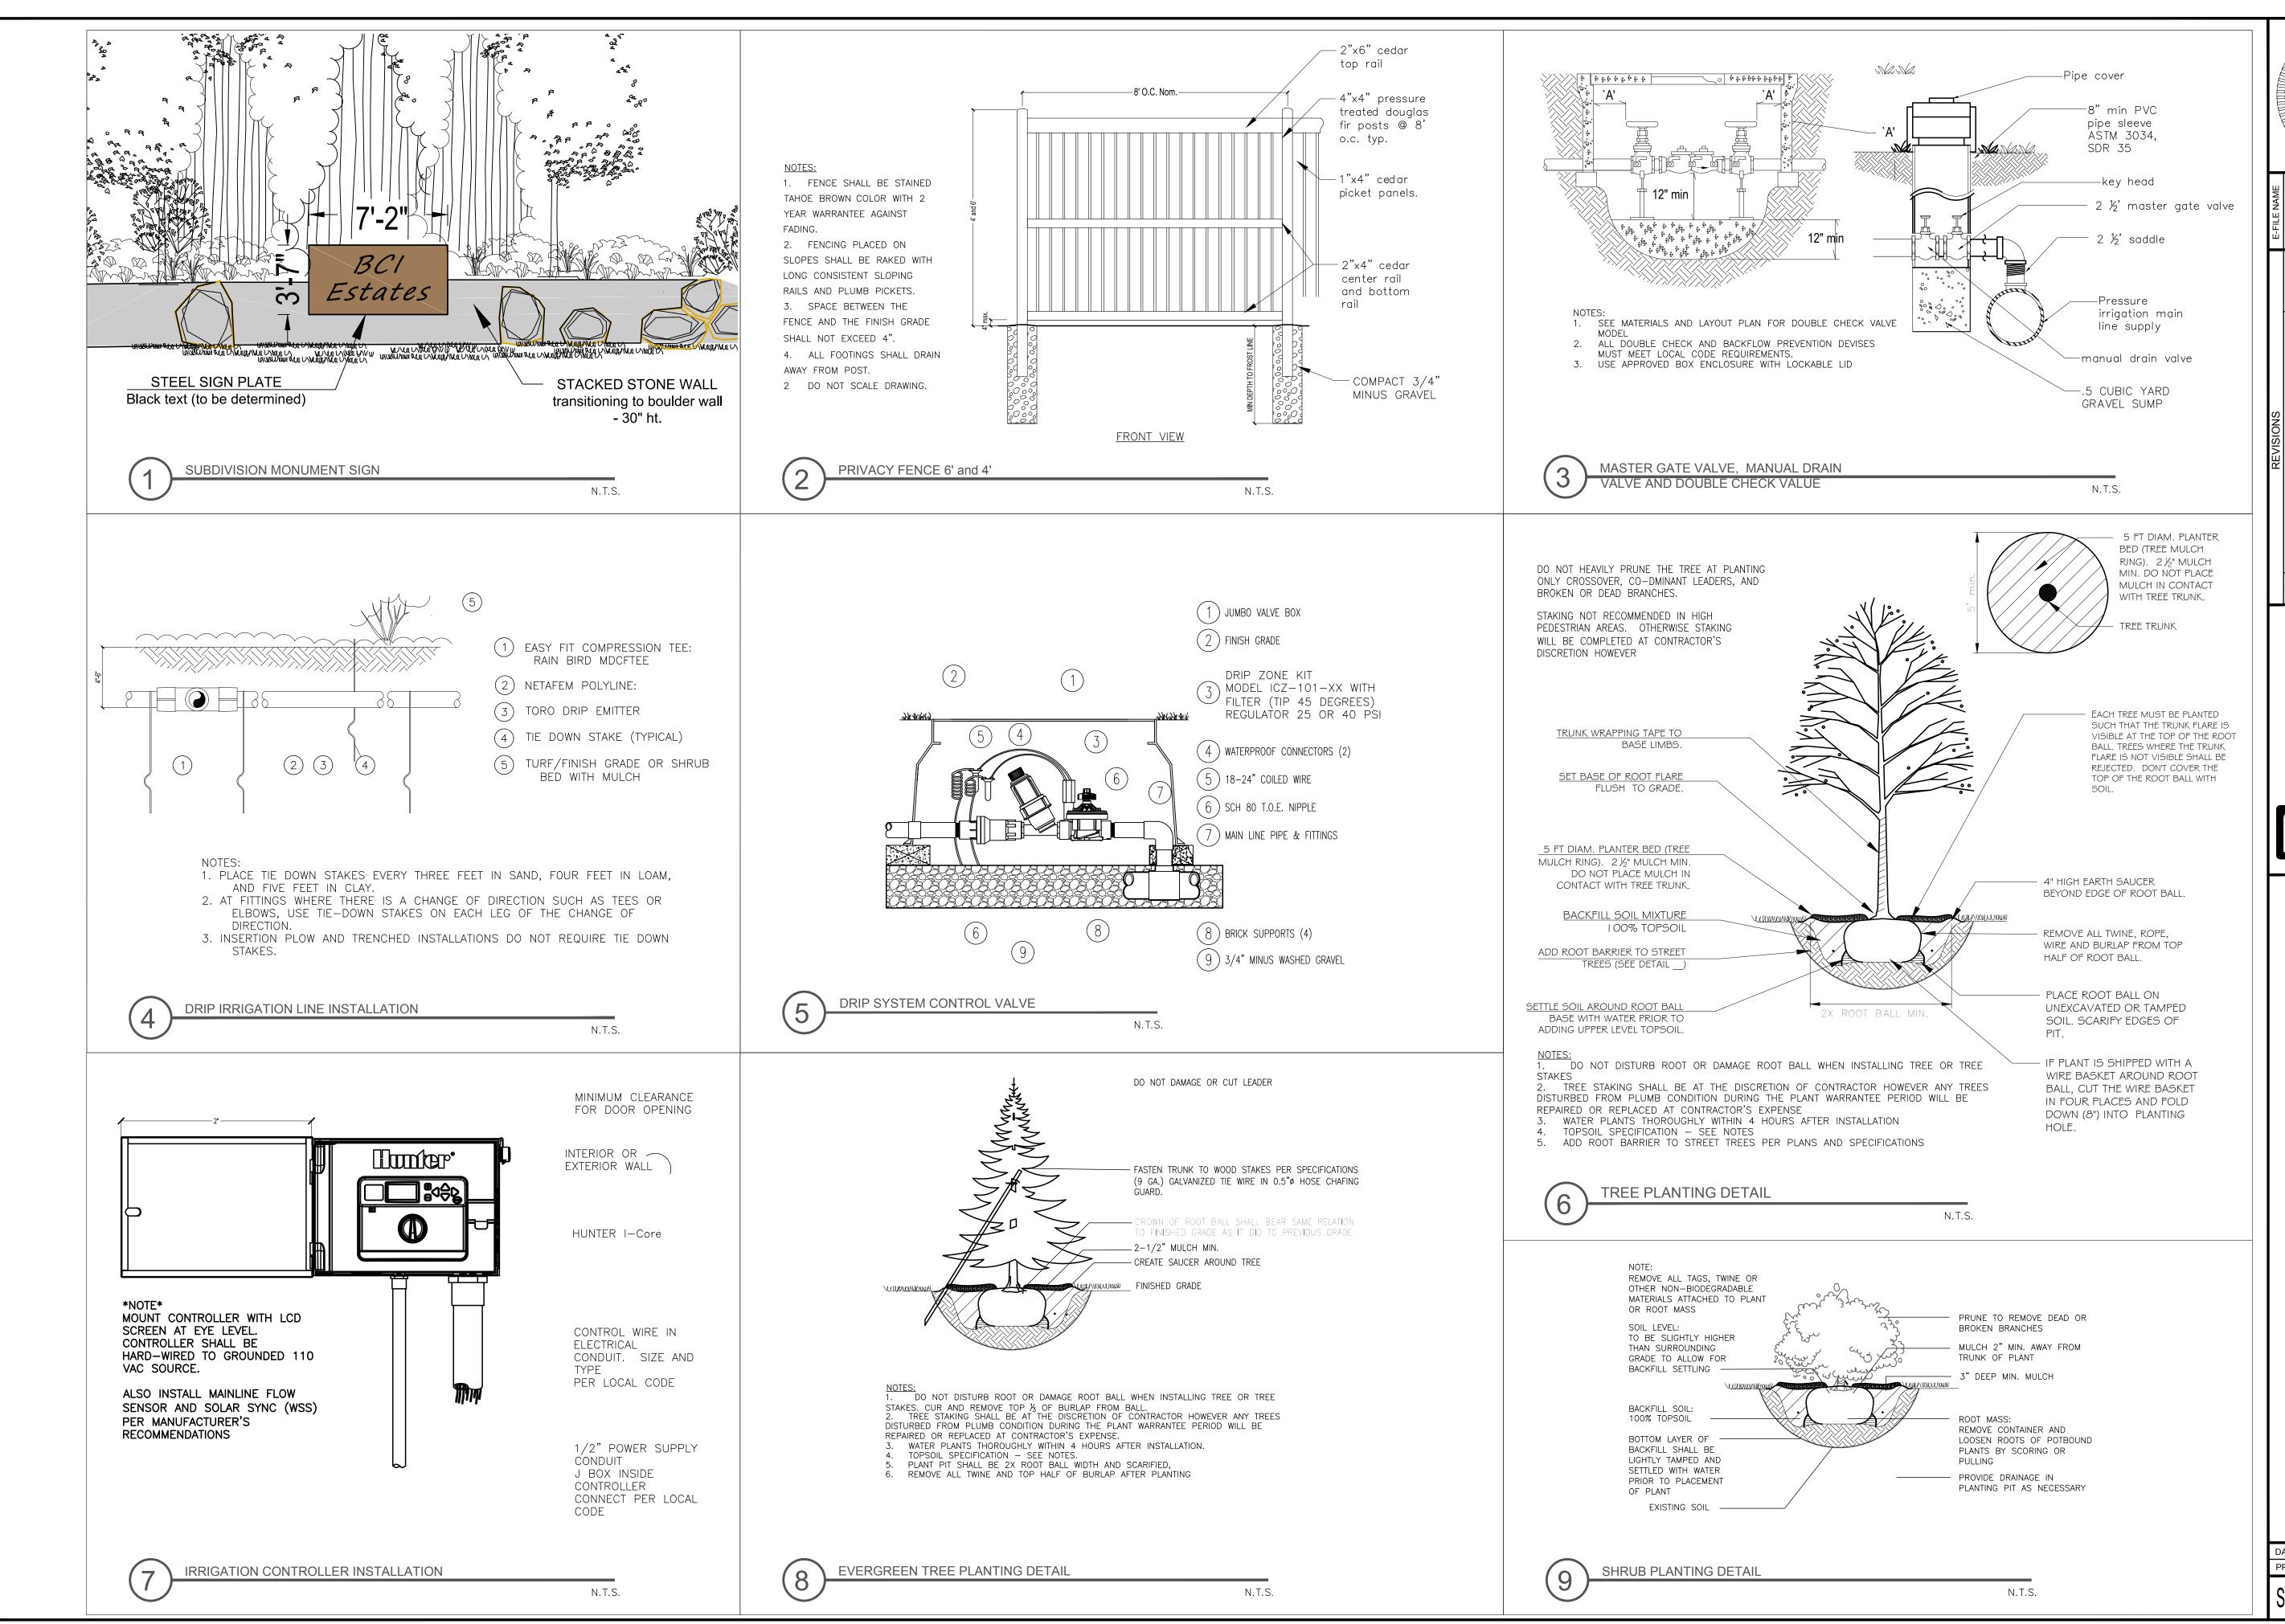
4. PLANTS SHOWN AT NEAR MATURE SIZE.

LOT 23 LOT 24 LOT 25 LOT 20 LOT 21 Existing Privacy Fence — (190lf) PLANTING PLAN SCALE: 1" = 30'

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E-FILE NAME	160030-LSCP	DESIGNED	S. PARKS	DRAWN	S. PARKS	СНЕСКЕD	-	APPROVED	SAGVOS
	DATE	03/14/2016	03/29/2016	08.23.2016	09.14.2016				
REVISIONS		New site plan with 30ft defensible zone and 20ft LS buffer	Change sidewalk locations	Site plan changes - south side	City of Boise Revised Conditions				

LANDSCAPE **PRELIMINARY**

SHEET L2.2 OF 4



HARMON ACAPHMENMONE VERMAN SCD BECCEN DE DI AT DEVO 14 2046 DIMIC 04402046

DATE: MARCH 2016
PROJECT: 160030

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SHEET L3 OF 4